

GENERAL NOTES:

ALL DRAWINGS TO BE READ IN CONJUNCTION WITH RELEVANT STRUCTURAL ENGINEERS DRAWINGS AND M&E DRAWINGS.

PRINCIPAL ENTRANCE TO HAVE LEVEL THRESHOLD & CLEAR OPENING OF MIN. 775MM, REFER TO DETAIL DRAWING 1705-550.

ALL INTERNAL DOORS TO PROVIDE CLEAR OPENING OF MIN. 775MM., PROVIDED VIA 838MM WIDE DOOR. ALL INTERNAL CORRIDOR WIDTHS TO BE MIN. 750MM. ALL INTERNAL DOORS TO BE FD30 FIRE DOORS, UNLESS STATED OTHERWISE, & THOSE TO THE SHOWER ROOM

DOOR & WINDOW NOTES:

FOR THE LOCATION OF WINDOWS & DOORS PLEASE REFER TO GA FLOOR PLANS. REFER TO SCHEDULES, SPECIFICATION, NOTES BELOW & INDIVIDUAL UNIT DATA SHEETS FOR FIRE RATING & ADDITIONAL DETAILS.

ALL OVERALL DIMENSIONS SHOWN ARE STRUCTURAL OPENINGS (AS NOTED) FOR WINDOW/DOOR TO FIT BETWEEN RHS STRUCTURE WELDED IN PLACE. MANUFACTURERS SHOULD ALLOW FOR TOLERANCES TO FIT.

ALL WINDOWS TO BE DOUBLE GLAZED WITH UPVC FRAMES, (UNLESS STATED OTHERWISE)
EXTERNAL COLOUR ANTHRACITE GREY (RAL 7016), INTERNAL COLOUR WHITE (RAL 9010), SUPPLIED BY CAMDEN GROUP. - SEE INDIVIDUAL UNIT DATA SHEETS FOR HANDING & ADDITIONAL INFO.
CLADDING PANEL COLOUR AS PER DATA SHEETS.
MINIMUM U-VALUES TO BE ACHIEVED FOR EXTERNAL DOORS & WINDOWS 1.6W/M²K
MINIMUM U-VALUE FOR CLADDING INFILL PANEL TO BE 0.35W/M²K

EXTERNAL DOORS TO BE COMPOSITE FD30s FIRE DOOR, BOHEMIA TWIN DOOR (BLACK STANDARD) AS SUPPLIED BY HURST DOORS. DOOR TO BE COMPLETE WITH SMOKE SEAL & SELF CLOSING DEVICE.

WINDOWS & DOORS TO BE INCLUSIVE OF EXTERNAL CILLS, WEATHER BARS, INTERNAL WINDOW BOARDS & ALL RELATED HINGES & HARDWARE.

WINDOWS TO BE FITTED WITH TRICKLE VENTS AS NOTED ON SCHEDULES, TO AID BACKGROUND VENTILATION AS REQUIRED, MANUFACTURER TO RECOMMEND PLACEMENT OF VENTS, I.E WINDOW JAMB OR HEAD.

INSULATED PANEL WITHIN WINDOW TO ACHIEVE MIN. B1 'DIFFICULT TO IGNITE' REACTION TO FIRE RATING TO ALL PANELS & CLASS 0 SURFACE SPREAD OF FLAME (WHERE REQUIRED). REFER TO INDIVIDUAL UNIT DATA SHEETS FOR ANY SPECIFIC WINDOW FIRE PERFORMANCES REQUIRED.

INTERNAL DOORS (APART FROM TO SHOWER ROOM) TO BE INCLUSIVE OF INSTUMESCENT FIRE GRILLE TO AID VENTILATION, 100MM X 100MM, IN BOTTOM OF DOOR. INTERNAL DOOR TO SHOWER ROOM TO BE UNDERCUT TO AID BACKGROUND VENTILATION.
HINGES ON FIRE DOORS MUST BE CE MARKED FOR USE ON FIRE DOORS. SCREWS, LOCKS & THE POSITIONS OF INSTALL ON ALL FIRE DOORS MUST BE INSTALLED AS PER MANUFACTURERS REQUIREMENTS.
ALL DOOR FURNITURE AND IRONMONGERY TO BE AS PER MANUFACTURERS REQUIREMENTS & RECOMMENDATIONS IN ORDER TO MEET FIRE DOOR SPECIFICATION.

ENSURE WINDOWS PROVIDE OPENABLE AREA TO ENABLE EQUIVALENT OF 1/20TH OF ROOM FLOOR AREA FOR RAPID VENTILATION.

TRICKLE VENTS TO BE SIZED AS PER WINDOW & DOOR SCHEDULES, TO BE TRIM VENT 90 HI-LIFT

ALL HINGES & HARDWARE TO BE BRUSHED STAINLESS STEEL.
ALL GLAZING BELOW 800MM FROM FFL TO BE TOUGHENED GLASS, DENOTED AS TG ON DRAWINGS.

ALL WINDOWS & DOORS TO BE INCLUSIVE OF BLINDS, CLIENT TO CONFIRM SPECIFICATION.

WINDOWS & DOORS TO ACHIEVE MINIMUM STANDARDS AS SET OUT IN PAS 24:2012 / BS7950 & BS6375. TO BE SBD & APPROVED DOCUMENT PART Q COMPLIANT.

WINDOWS & DOORS TO BE INSTALLED BY FENSA APPROVED INSTALLER TO MANUFACTURERS DETAILS.

MANIFESTATION

FULL HEIGHT WINDOWS ARE HALF SPLIT WITH TOP HUNG LIGHTS, WITH CONTRASTING FRAME (& MULLION) THICKNESS TO VISUALLY BREAK GLAZING.

TG = TOUGHENED GLASS
FR = FROSTED GLASS

CDM 2015
RESIDUAL RISK

THR CONTRACTORS SHALL FAMILIARISE THEMSELVES WITH THE PROJECT AND EMPLOY SYSTEMS AND METHODS OF WORKING TO REDUCE ANY HAZARDS

THE CONTRACTORS SHALL PLAN, MANAGE, MONITOR AND COORDINATE HEALTH AND SAFETY DURING THE CONSTRUCTION PHASE OF A PROJECT


IF IN DOUBT ASK AND NOTIFY THE DESIGN TEAM

GENERAL

IT IS ASSUMED THAT A COMPETENT CONTRACTOR FAMILIAR WITH THE WORKS REQUIRED WILL BE APPOINTED AND THAT THEY WILL BE AWARE OF THE STANDARD HAZARDS.

NOTES:

- DRAWINGS SHOULD ONLY BE SCALED FOR PLANNING PURPOSES. DO NOT SCALE FROM THIS DRAWING FOR CONSTRUCTION PURPOSES.
- ALL DIMENSIONS ARE IN MM, UNLESS STATED OTHERWISE.
- ALL DIMENSIONS TO BE CHECKED ON SITE PRIOR TO CONSTRUCTION OR ORDERING.
- ANY ERRORS OR OMISSIONS TO BE NOTIFIED TO CITIZEN LLP IMMEDIATELY.
- CONTRACTOR TO READ & CHECK ALL MANUFACTURES LITERATURE AND IMPLEMENT ITS REQUIREMENTS PRIOR TO INSTALLATION OF ANY MATERIALS AND COMPONENTS.
- CITYZEN LIMITED IS NOT RESPONSIBLE FOR ANY BUILDING WORK THAT IS CARRIED OUT ON SITE.
- THIS DRAWING IS TO BE READ IN CONJUNCTION WITH ALL NECESSARY ARCHITECTURAL, STRUCTURAL AND SPECIALIST DRAWINGS, SPECIFICATIONS, SCOPES OF WORK & ROOM DATA SHEETS.
- ALL MATERIALS AND WORKMANSHIP SHALL CONFORM WITH THE RELEVANT BRITISH AND EUROPEAN STANDARD, SPECIFICATIONS AND CODES OF PRACTICE.
- IF IN ANY DOUBT, ASK.
- WALKWAY DESIGN BY OTHERS. FINAL WALKWAY JUNCTIONS TBC.
- CONTAINER DIMENSIONS CAN VARY. ALL DIMENSIONS SHOULD BE CHECKED BEFORE SITE INSTALLATION.

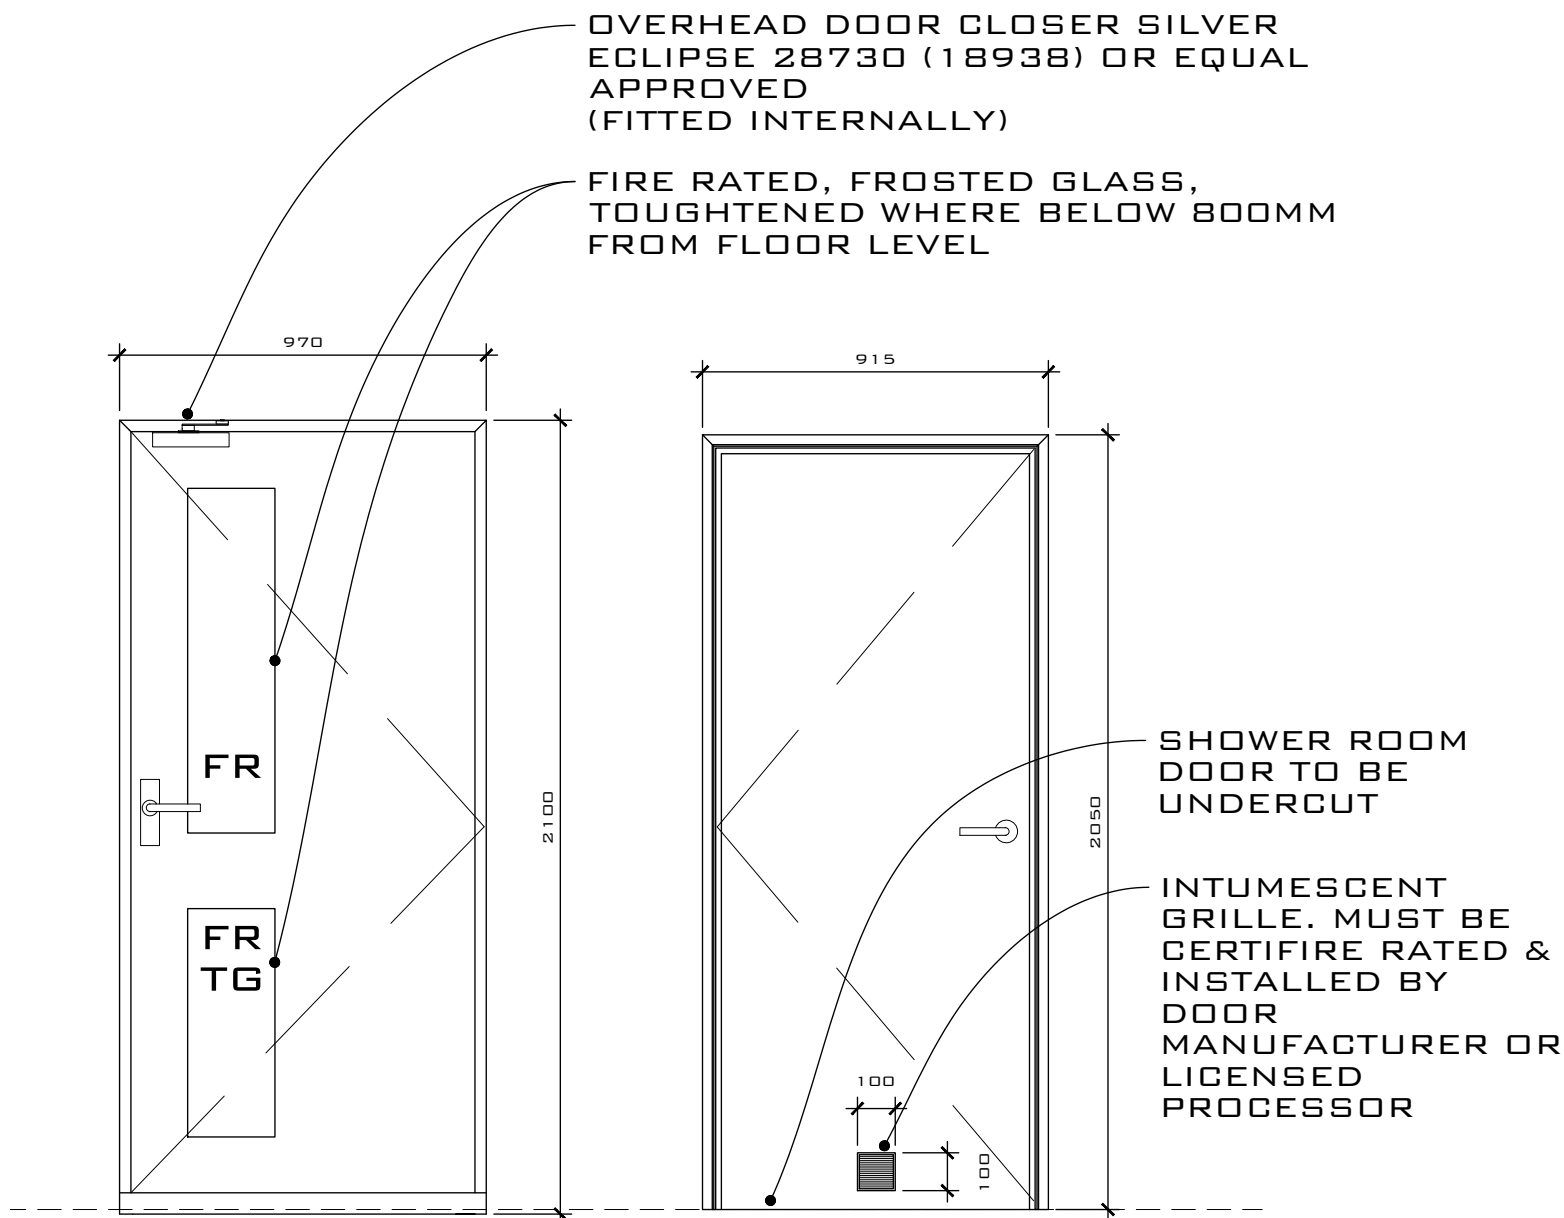


DOOR TYPE 1:
EXTERNAL DOOR

970 x 2100MM
STRUC.


DOOR TYPE 2:
INTERNAL DOOR

915 x 2050MM STR
(838 x 1981MM DO

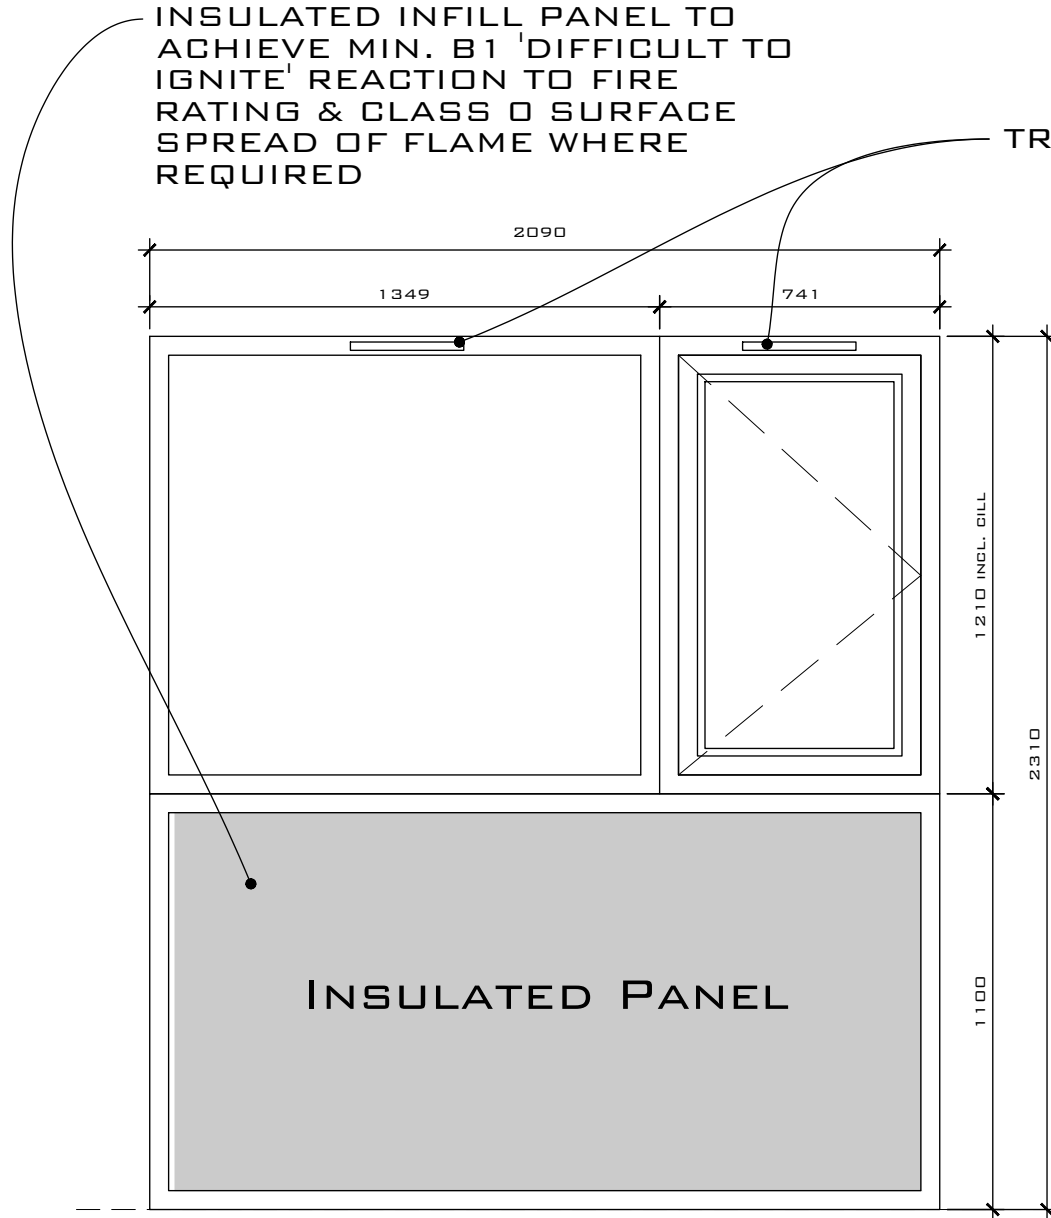


WINDOW TYPE 1:
DOUBLE CASEMENT

2090 x 2310MM STRUC.

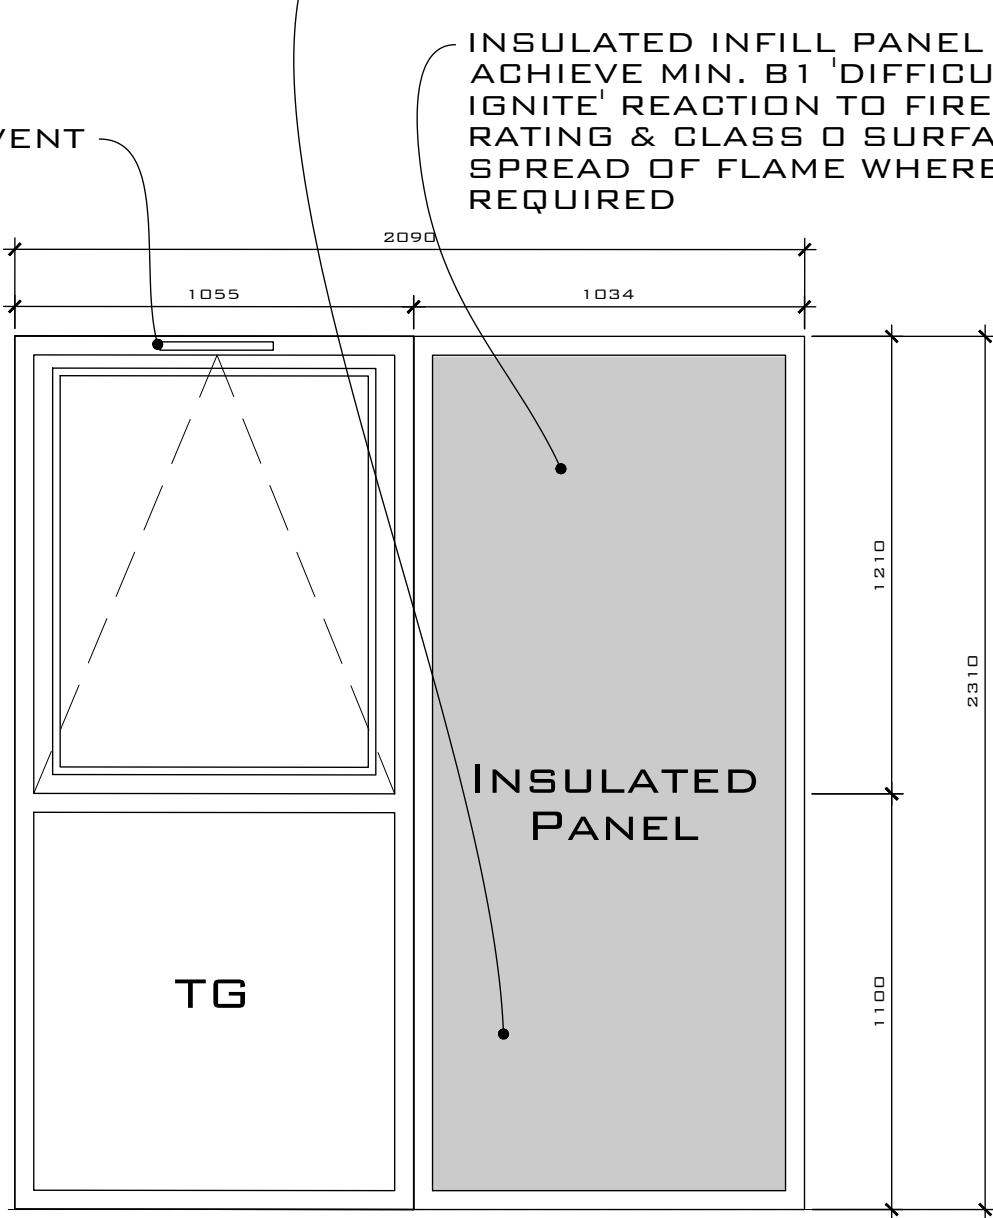


WINDOW TYPE 2:
SINGLE CASEMENT

2090 x 2310MM STRUC.

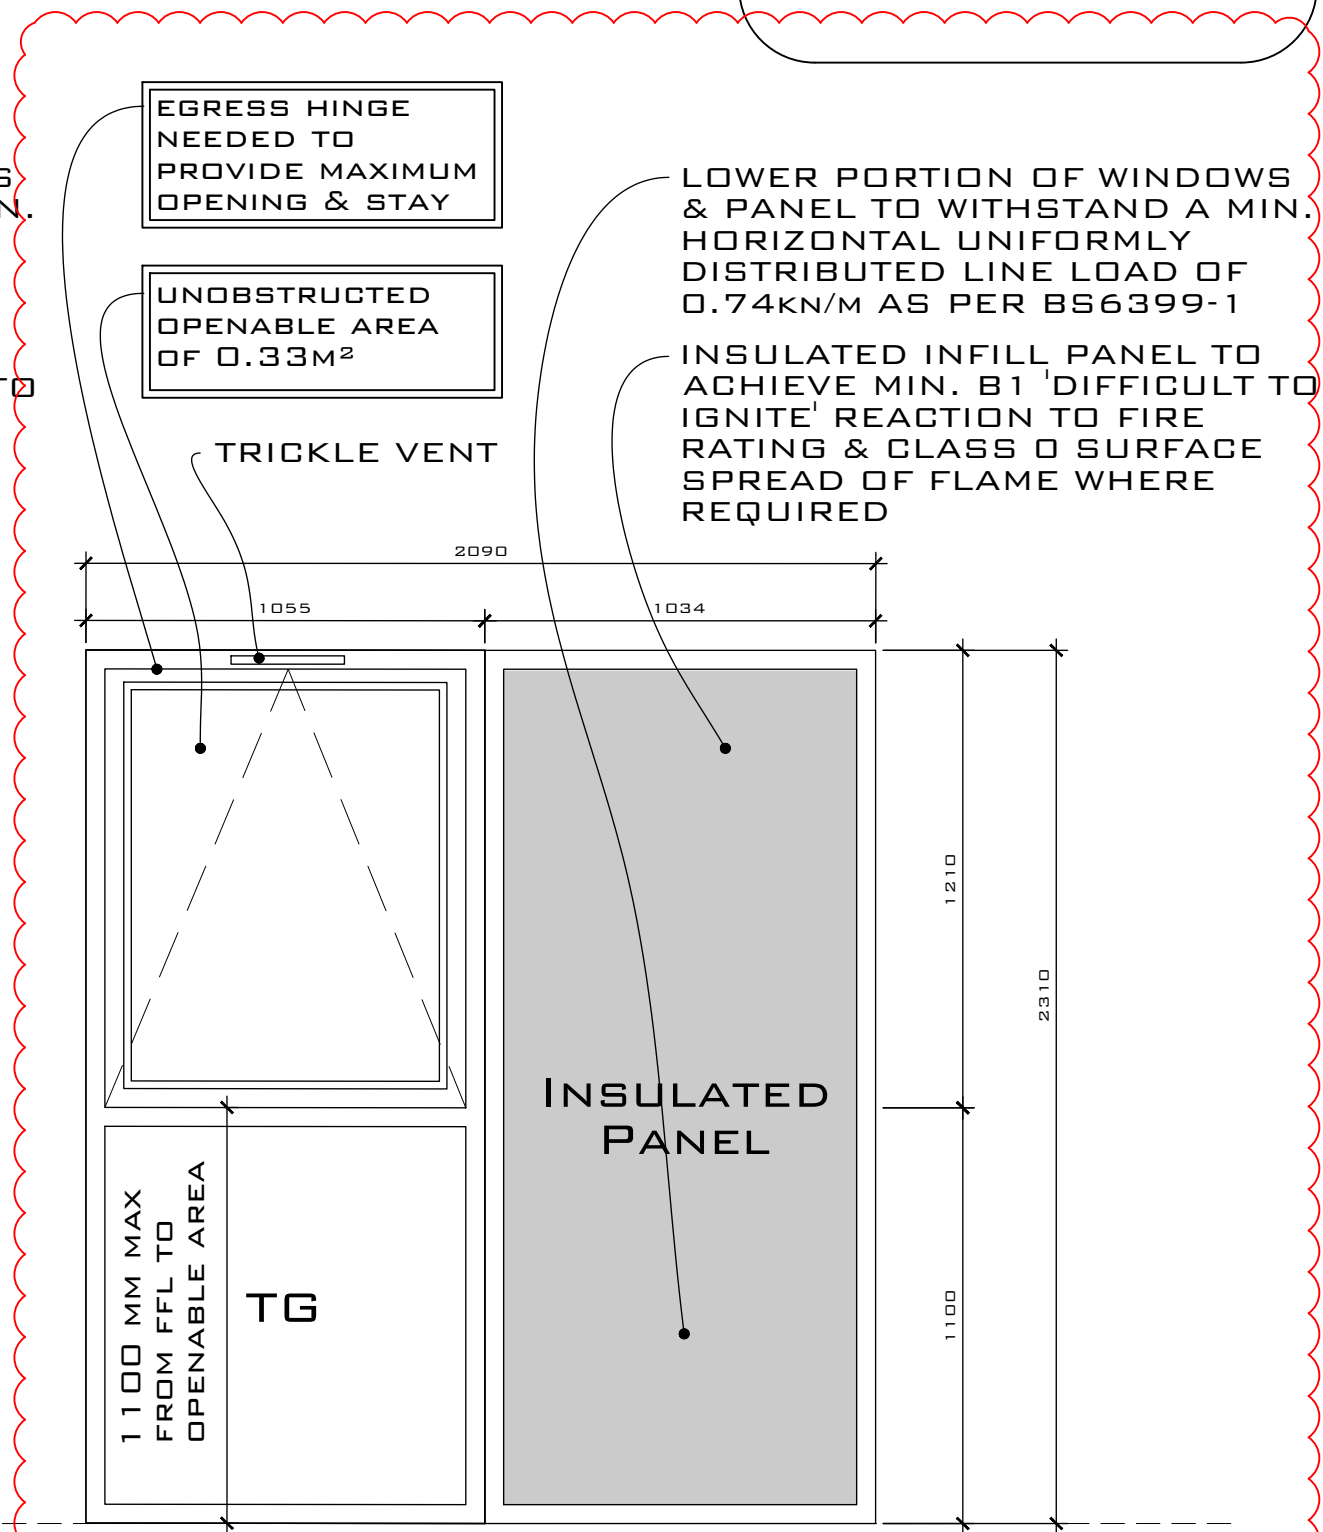


WINDOW TYPE 2 - ONLY AT UNIT E06
(UNIT TYPE 1 AT GROUND FLOOR ONLY)
SINGLE CASEMENT

2090 x 2310MM STRUC.

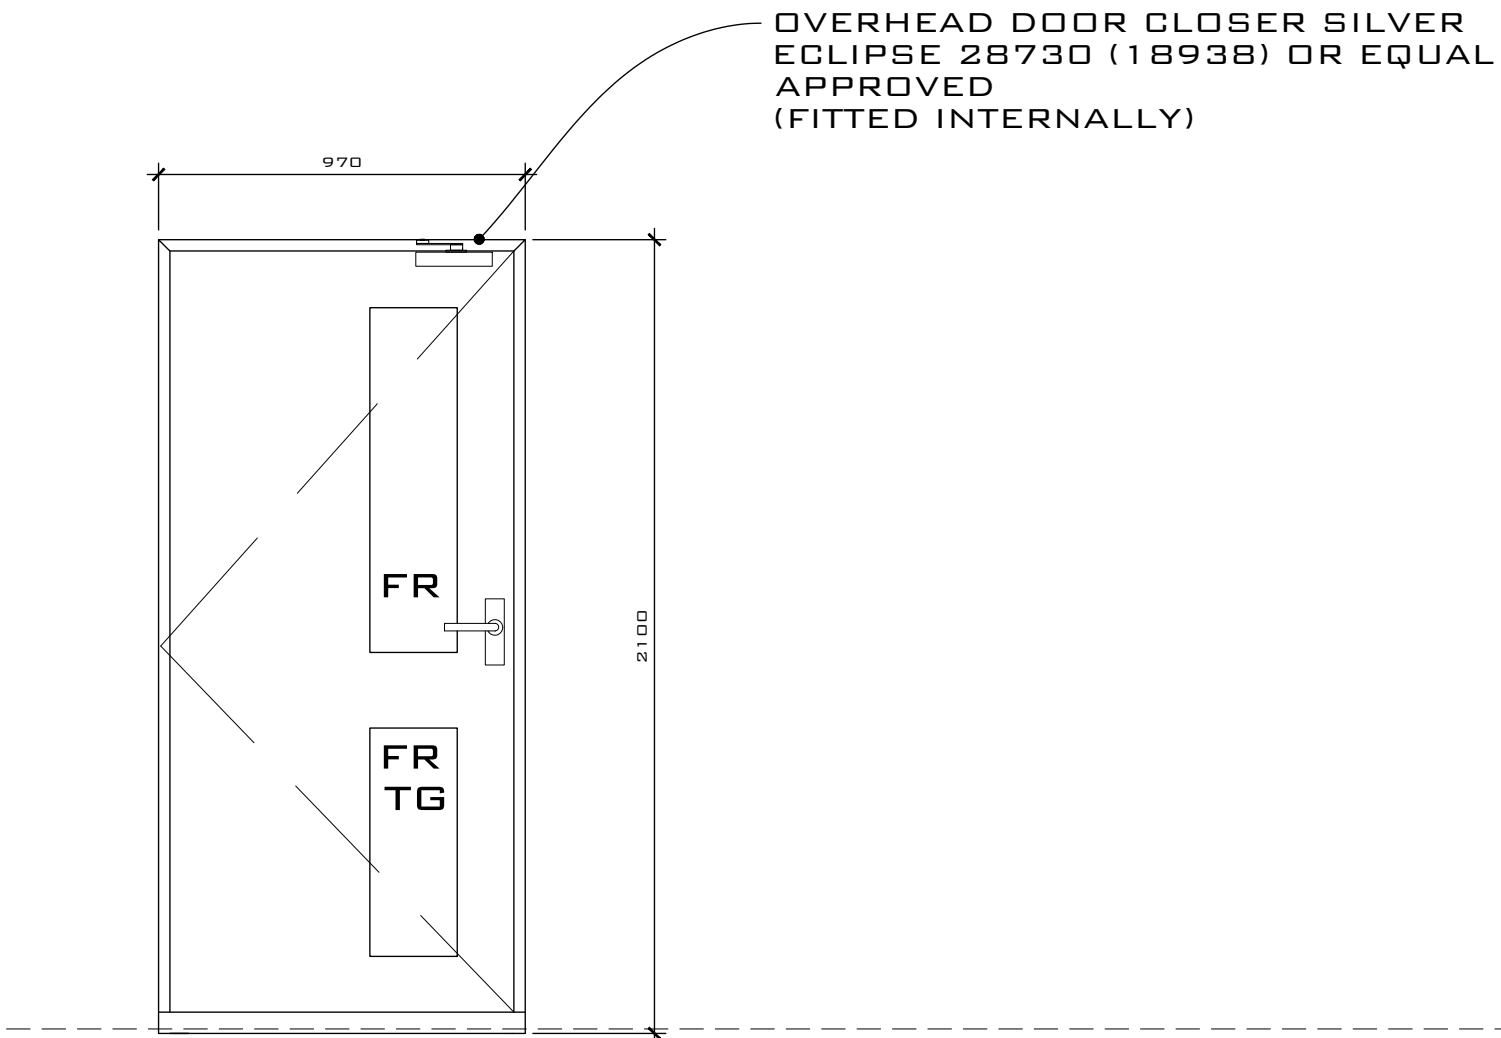


DOOR TYPE 1H:
EXTERNAL DOOR

970 x 2100MM STRUC.

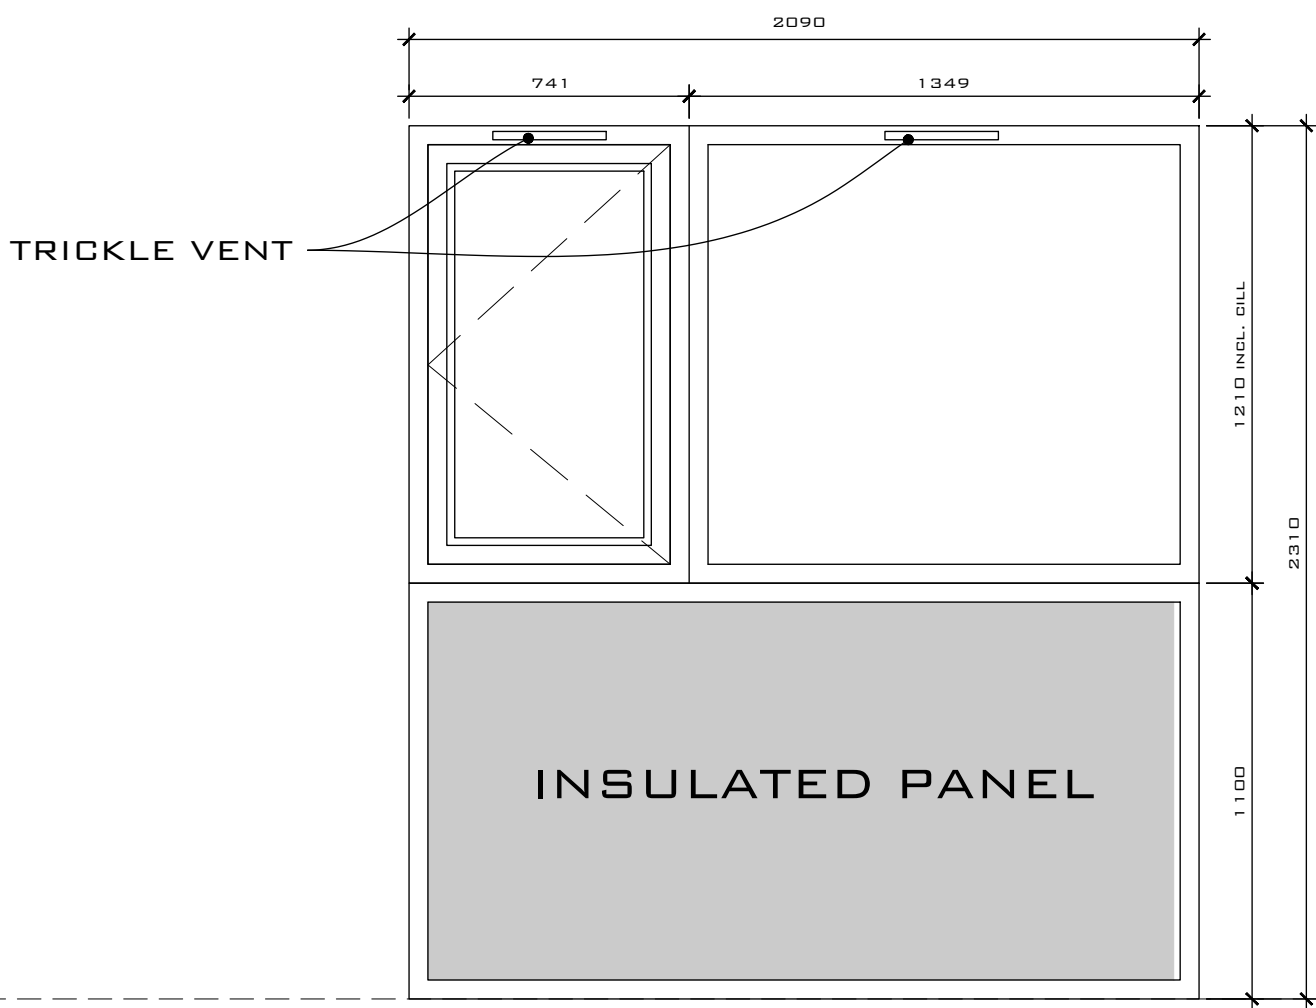

WINDOW TYPE 1H:
DOUBLE CASEMENT


2090 x 2310MM STRUC.

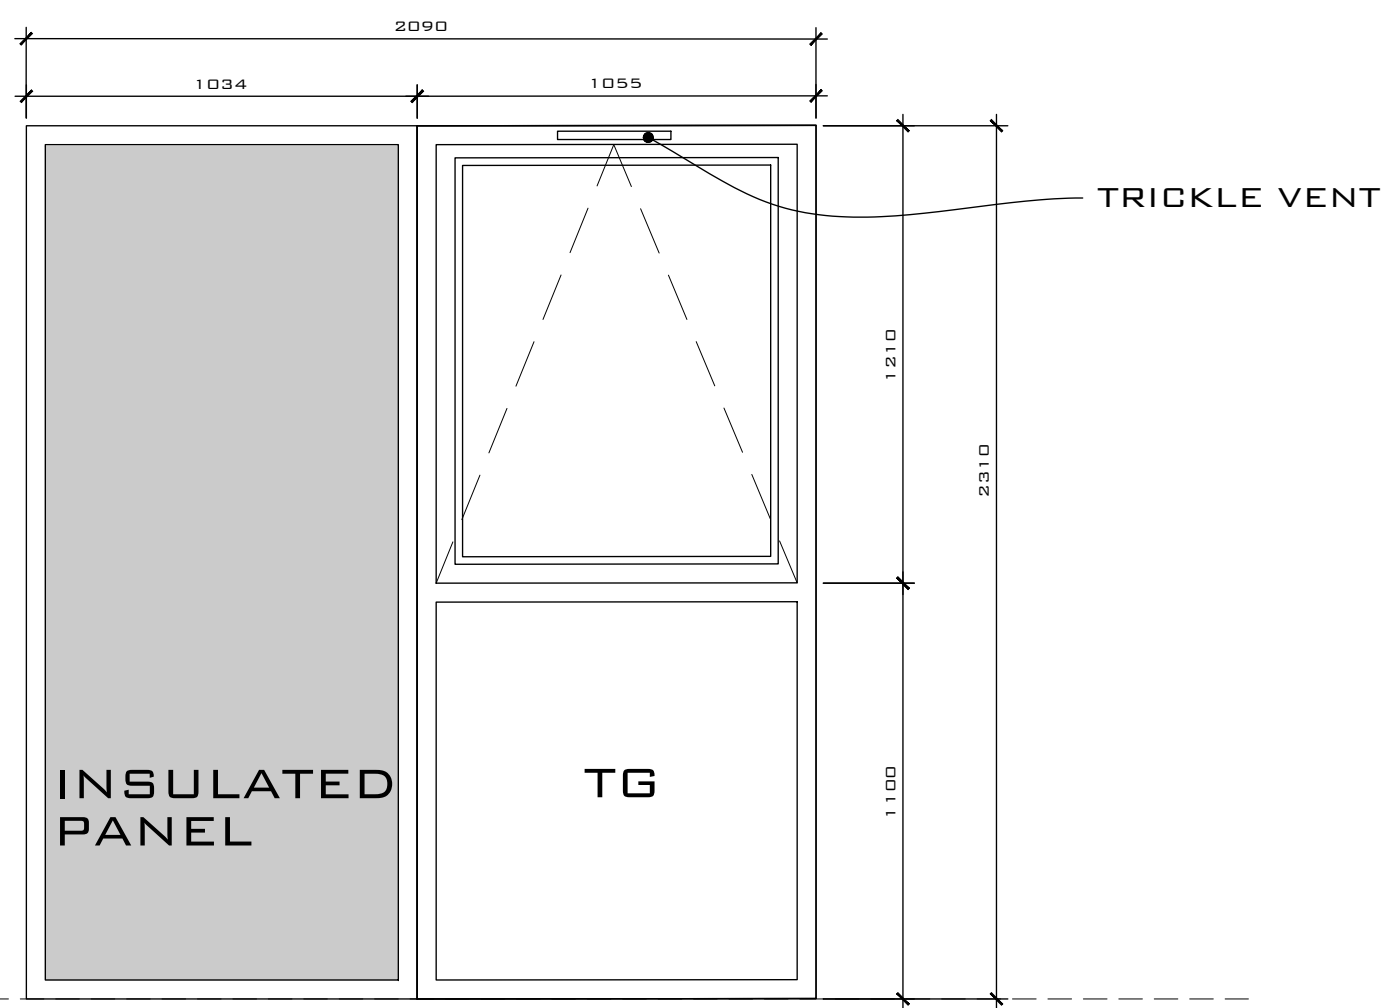

WINDOW TYPE 2H:
SINGLE CASEMENT

2090 x 2310MM STRUC.

DRAWING SCALE 1:20 @ A1
DRAWING SCALE 1:40 @ A3

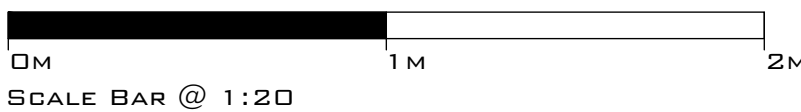

REV	DATE	REVISION	DRAWN	CHECKED	APPROVED
I	26.09.17	SPECIAL WINDOW TYPE 2 ADDED, ONLY FOR UNIT E06, TYPE 01 GROUND FLOOR	AG	JS	JS
H	21.07.17	WINDOW TYPE 2H SIZE NOTE AMENDED	RS	JS	JS
G	06.07.17	ADDITIONAL NOTES ADDED	RS	JS	JS
F	26.06.17	ADDITIONAL FIRE RATING NOTES ADDED	RS	JS	JS
E	23.06.17	REVISED IN LINE WITH CLIENT & CONTRACTOR COMMENTS, DOOR TYPE 03 REMOVED, HANDED DOORS & WINDOWS ADDED	RS	JS	JS
D	08.06.17	FRONT DOOR REVISED TO HURST DOOR, NOTES ADDED/REVISED	RS	JS	JS
C	02.06.17	REVISED IN LINE WITH DTM & ISSUED FOR CONSTRUCTION	RS	JS	JS
B	21.04.17	GENERAL REVISIONS FOLLOWING DTM	RS	JS	JS
A	27.03.17	GENERAL REVISIONS TO NOTES FOLLOWING DTM & CONTRACTORS COMMENTS	RS	JS	JS

COPYRIGHT CITYZEN LIMITED

CITYZEN
ARCHITECTURE | ENVIRONMENT
MARITIME HOUSE
BASIN ROAD NORTH
HOVE
EAST SUSSEX
BN41 1WR
CONTACT@CITYZENDESIGN.CO.UK
WWW.CITYZENDESIGN.CO.UK
01273 704 901



CLIENT:
CARGOTEK

DESIGNER:
ROMAN SCHNECKER

PROJECT:
CARGOTEK 20FT PRODUCT

TITLE:
DOOR & WINDOW LEGEND

SCALE: 1:20 @ A1
DATE: MAR 17

PURPOSE OF DRAWING:
CONSTRUCTION

DRAWING: PROJECT REF - DRG NO. (REVISION)
1705-CR-650 (1)